
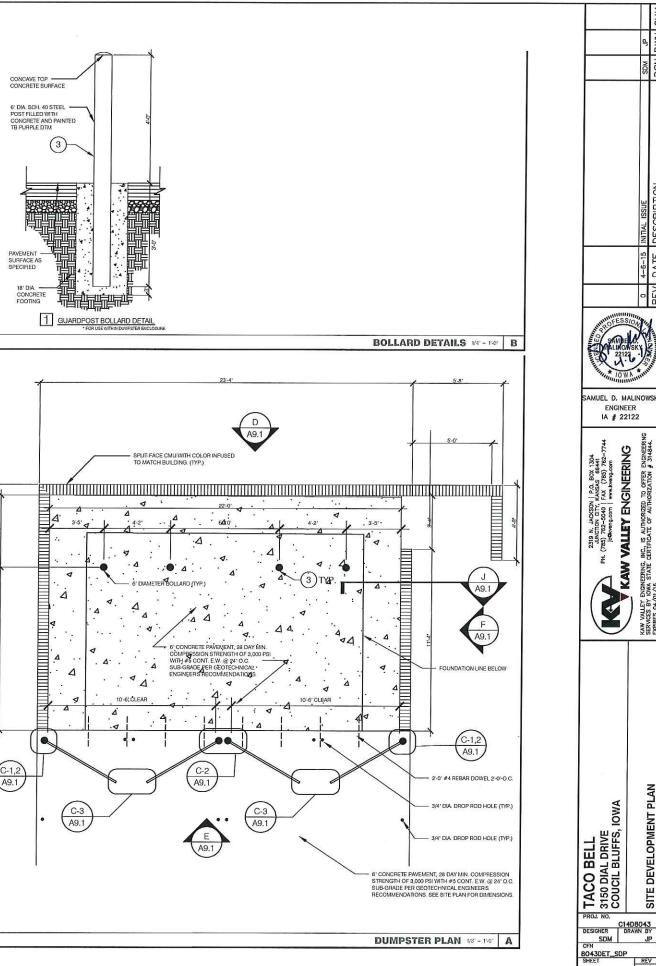


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2 OF 2

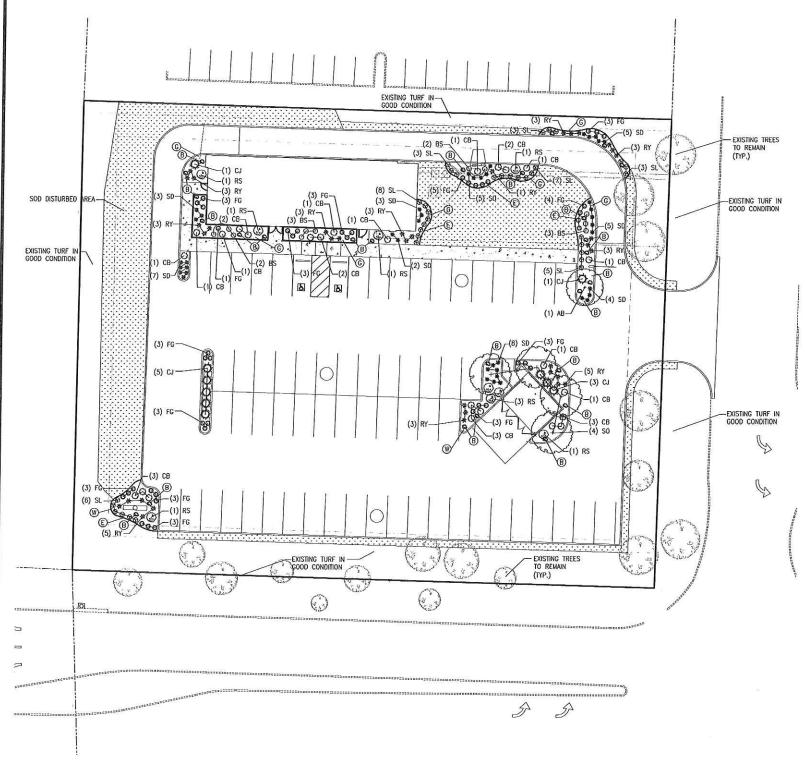

A SITE PLANTING PLAN 0' 10' 20' 40'1"=20.0'

			PLANTING LIST		
KEY	QTY.	COMMON NAME	BOTANICAL NAME	SIZE	COND.
TRE	ES:				-1140-22
AB SO	1 4	AMERICAN BEECH SAWTOOTH OAK	FAGUS GRANDIFLORA QUERCUS ACUTISSIMA	2" MIN. CAL. 2" MIN. CAL.	B & 1
SHI	RUBS 42	 GRASSES PERENNI stella de oro daylily	ALS: HERMEROCALLIS 'STELLA DE ORO'	1 GAL	CONT
BS	11	BLUE HILL MEADOW SAGE	SALVIA X SYLVESTRIS 'BI UF HILL'	1 GAL	CONT
FG	43	FEATHER REED GRASS	CALAMAGROSTIS ACUTIFLORA 'KARL FOERSTER'	2 GAL	CONT
CB	25	CRIMSON PYGMY BARBERRY	BERBERIS THUNBERGII 'CRIMSON PYGMY'	3 GAL.	CONT
RY	35	BRAKELIGHTS RED YUCCA	HESPERALOE PARVIFLORA 'PERPA'	3 GAL.	CONT
RS	9	RUSSIAN SAGE	PEROVSKIA ATRIPLICIFOLIA	2 GAL.	CONT
SL	35	SILVERY SUNPROOF LIRIOPE	LIRIOPE MUSCARI 'SILVERY SUNPROOF'	1 GAL	CONT
CJ	13	COMPACTA ANDORRA JUNIPER	JUNIPERUS HORIZONTALIS 'PLUMOSA COMPACTA'	5 GAL.	CONT
		ALEXAN - ALEXANDER MILLION AND ALEXANDER MANAGEMENT AND ALEXANDER MANAG	Section in the section of the sectio	40.004.004.000	1

PLANTING NOTES

- 1. NO SUBSTITUTIONS SHALL BE ALLOWED WITHOUT OWNER'S APPROVAL.
 QUANTITIES IN THE PLANT LIST ARE FOR INFORMATION ONLY. CONTRACTOR SHALL VERIFY.
 2. ALL PLANT LOCATIONS ARE APPROXIMATE, ADJUST AS NECESSARY TO AVOID CONFLICTS.
 3. EDGING SHALL BE STEEL PER SPCC, OR OWNER APPROVE EQUAL. INSTALL STAKES IN
 ACCORDANCE WITH MANUFACTURER'S RECOMMENDATION.
 4. THE PLANTING BEOS RECEMING MULCH SHALL BE TREAD WITH A PRE-EMERGENT HERBICIDE
 PRIOR TO POLATING AND MULCH PLACEMENT, APPLY IN ACCORDANCE WITH STANDARD TRADE
 PRACTICE.
 5. WEED BARRIER FABRIC, AS NOTED IN THE SPECIFICATIONS, SHALL BE INSTALLED IN ALL SHRUB
 PLANTING BEOS TO RECEME GRAVEL MULCH.
 6. TURE SOO SHALL MARCH EXISTING VARBETY ON SITE.
 7. WHEN CLAY SOIL IS ENCOUNTERED IN THE ESTABLISHMENT OF THE LAWN OR THE INSTALLATION
 OF PLANT MATERIA, SOIL SHALL BE IMPROVED IN ACCORDANCE WITH STANDARD TRADE
 PRACTICE. i.e. ADDITION OF LIME, GYPSUM, ETC.
 8. MAY PLANTING BEO SAND EXHAL TO ALLOW THE TOP OF THE MULCH TO MATICH THE TOP OF WALK OR
 CURBING. EDGING SHALL BE INSTALLED BETWEEN PLANTING SEDS AND TURF DO NOT
 9. INSTALL EDGING BETWEEN PLANTING BEOS AND CURBIS SIDEMALK EDGES.
 10. DO NOT GRADE PLANTING BEOS SHALL HAVE EVEN SMOOTH SLOPES.
 11. GRAVEL MULCH SHALL BE 15T TO 2" DIA NATIVE RIVER ROCK

PLANTING NOTES

Large deciduous shade trees shall be installed in parking lots in excess of 30 spaces. One tree per each 3,000 square feet of paying on site. (28,500 sf = 10 $\,$ TREES REQUIRED; 5 TREES PROVIDED)

LEGEND



APPROX, LIMITS OF SOD - MATCH EXISTING VARIETY SOD ALL DISTURBED TURF AREAS $\,$

* O O * PROPOSED SHRUBS AND GRASSES

±24" BOULDERS (SIMILAR TO GRAVEL MULCH)


3" LAYER OF GRAVEL MULCH


3" LAYER OF BROWN HARDWOOD MULCH

4" STEEL LANDSCAPE EDGING (SEE PLANTING NOTES)



EXISTING TREE TO REMAIN

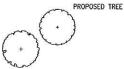

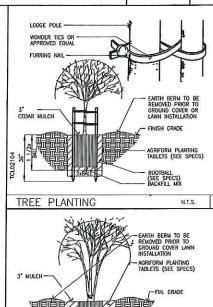

SHRUB PLANTING

-ROOTBALL

N.T.S. 2





Lee B. Manske My license renewal date is June 30, 2015.

14023.030

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CONTRACT DATE: XX.XX.XX BUILDING TYPE: LIVE MAS LARGE66 PLAN VERSION: MARCH 2015 SITE NUMBER: XXX-XXX STORE NUMBER: XXXXX

TACO BELL


3150 DIAL DRIVE COUNCIL BLUFFS, IA



PLANTING PLAN **LP101**

PLOT DATE:

3-26-15

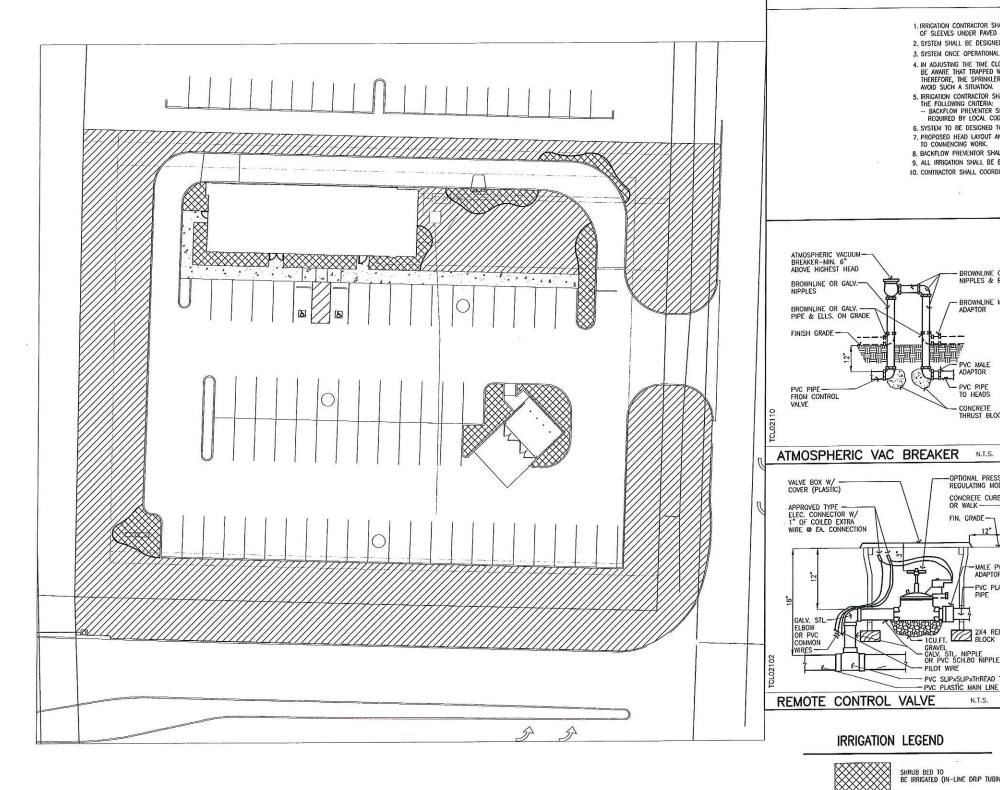

IRRIGATION NOTES

- 1. Irrication contractor shall coordinate with paying contractor on the timing of the installation of sleeves under payed areas. Installation of sleeves is responsibility of irrigation contractor.
- 2. SYSTEM SHALL BE DESIGNED AND INSTALLED TO MEET THE CRITERIA OUTLINED IN THE PERFORMANCE SPEC. 3. SYSTEM ONCE OPERATIONAL SHALL BE CAPABLE OF APPLYING 1" OF WATER PER WEEK TO ALL LANDSCAPE AREAS.
- 4. IN ADJUSTING THE TIME CLOCK ON THE IRRIGATION CONTROLLER, THE IRRIGATION CONTRACTOR SHALL BE AWARE THAT TRAPPED WATER BETWEEN WALKS AND THE BUILDINGS FOUNDATION IS A CONCERN. THEREFORE, THE SPRINKLER ZONES RESPONSIBLE FOR IRRIGATING THESE AREAS SHALL BE SET TO AVOID SUCH A SITUATION.
- 5. IRRIGATION CONTRACTOR SHALL COORDINATE BACKFLOW PREVENTER LOCATION, LOCATION SHALL MEET THE FOLLOWING CRITERIA:

 BACKFLOW PREVENTER SHALL BE INSTALLED AT THE DISTANCE ABOVE THE HIGHEST SPRINKLER HEAD AS
- REQUIRED BY LOCAL CODES.

PRESSURE TYPE VACUUM — BREAKER ASSEMBLY W/GATE VALVES

REDUCED PRESSURE TYPE — VACUUM BREAKER ASSEMBLY WITH GATE VALVES

RP/PRESSURE VAC. BRKR.

HEIGHT AS REQUIRED BY LOCAL PLUMBLING

AS PER LOCAL CODE FROM P.O.C. CONCRETE THRUST BLOCKS-

N.T.S.

- INSTALLATION OF HEAD PRIOR TO FINISH GRADING

FLUSH /W FINISH GRADE AT LAWN AREA

- CONCRETE CURB OR WALK POP-UP HEAD - PVC NIPPLE

- PVC STREET ELL.

N.T.S.

PVC SLIPXSLIPX
THREADED TEE

UNION (LIKE PIPE— OR AS PER LOCAL CODE)

-- PVC PLASTIC MAIN LINE TO VALVES

FIN. GRADE -

ABOVE GRADE — AT SHRUB AREAS

FIN. GRADE

PVC LATERAL-

SPRAY HEADS

- 6. SYSTEM TO BE DESIGNED TO AVOID SPRAYING WATER ON BUILDING OR ACROSS WALKS.
- 7. PROPOSED HEAD LAYOUT AND SYSTEM ROUTING SHALL BE SUBMITTED TO OWNER FOR APPROVAL PRIOR TO COMMENCING WORK.
- 8. BACKFLOW PREVENTOR SHALL BE ENCLOSED IN A LOCKABLE COVER DEVICE.
- 9. ALL IRRIGATION SHALL BE BASE BID.

- BROWNLINE OR GALV. NIPPLES & ELLS.

BROWNLINE MALE ADAPTOR

PVC PIPE TO HEADS

- CONCRETE THRUST BLOCKS

-OPTIONAL PRESSURE REGULATING MODULE

PIPE PLASTIC

3

CONCRETE CURB

2X4 REDWOOD - ICU.FT. BLOCK GRAVEL - GALV. STL. NIPPLE OR PVC SCH.80 NIPPLE

- PVC SLIPxSLIPxTHREAD TEE

- PVC PLASTIC MAIN LINE

FIN. GRADE -

10. CONTRACTOR SHALL COORDINATE LOCATION FOR IRRIGATION CONTROLLER WITH OWNER.





Lee B. Manske

My license renewal date is June 30, 2015.

14023.030

CONTRACT DATE: XX.XX.XX BUILDING TYPE: LIVE MAS LARGE66 PLAN VERSION: MARCH 2015 SITE NUMBER: STORE NUMBER: XXXXXX

> TACO BELL 3150 DIAL DRIVE

COUNCIL BLUFFS, IA



LIVE MAS **IRRIGATION**

CONCEPT PLAN

LI101






SHRUB BED TO BE IRRIGATED (IN-LINE DRIP TUBING)



TURF AREA TO BE IRRIGATED (SPRAY/ROTOR HEADS)

CONTRACTOR SHALL DETERMINE CONNECTION POINT TO DOMESTIC FOR IRRIGATION SUPPLY. PROVIDE SEPARATE METER FOR IRRIGATION SYSTEM



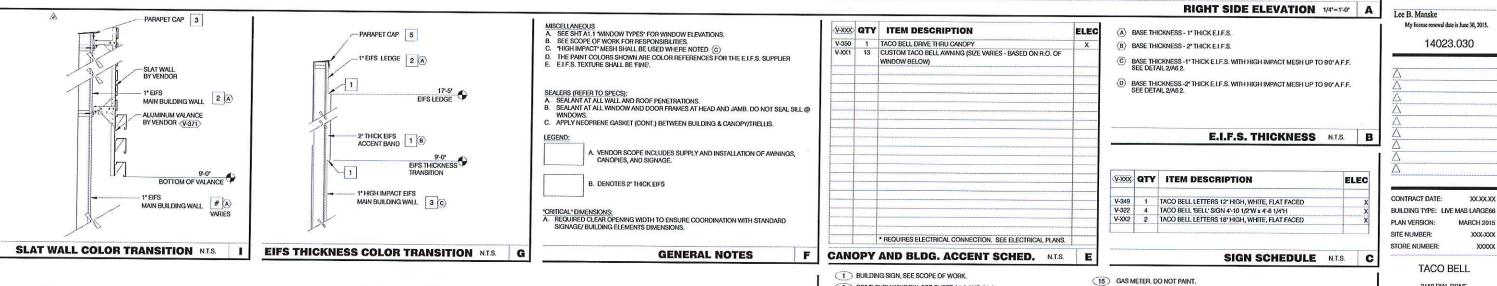

SYMBOL	AREA	MANUFACTURER	COLOR	ALTERNATE MFR.	ALTERNATE COLOR	CONTACT INFORMATION
1	MAIN BUILDING COLOR	SHERWIN WILLIAMS	SW 6122 'CAMEL BACK'	LOTUSAN	NA08-0011	SHERWIN WILLIAMS: BRAD HARRINGTON, 216-341-5558 X115 (PHONE),
2	WALL COLOR BEHIND SCREEN WALL	SHERWIN WILLIAMS	SW 6831 *CLEMATIS*			BRAD.E.HARRINGTON@SHERWIN COM EIFS CONTACT:
[3]	ACCENT COLOR	SHERWIN WILLIAMS	SW 2823 "ROOKWOOD CLAY"	LOTUSAN	NA08-0010	STO CORP.: CHUCK DUFFIN, 940-894-2092 (PHONE), 940-894-2095 (FAX), CDUFFIN@STOCORP.COM OWNER REPRESENTATIVE WILL IDENTIFY IF LOTUSAN PAINT WILL BE USED.
4	SLAT WALL AND VALANCE COLOR	VENDOR	SW 7034 "STATUS BRONZE" (EQUAL)	-		The state of the s
5	PARAPET CAP COLOR	DUROLAST	MEDIUM BRONZE (FACTORY FINISH)	SHERWIN WILLIAMS	SW 7069 "IRON ORE"	DURO-LAST:CURT JAFFEE, 800-356-6646 (PHONE), CJAFFE@DURO-LAST.COM
[6]	STONE WALL	BORAL - VERSETTA STONE	TIGHT CUT - PLUM CREEK*	CORONADO:	IDAHO DRY STACK, CARMEL MOUNTAIN CULTURED STONE VENEER - FULLY GROUTED.	VERSETTA STONE WALL: ASHLEY JOYCE, 770-845-4531 (PHONE) ALTERNATE: CORONADO: 1-800-847-8663
7	STOREFRONT WINDOWS	TBD	*DARK BRONZE*			
8	PIPE BOLLARDS	STREET SMART	YELLOW - 1/4" THCIK PLASTIC COVER (L	JS.POSTMAN.COM) OR E	:QUAL	
9	PARAPET BACK ROOFING	DUROLAST	THE COLOR SHALL BE FACTORY COLORED TAN. EQUAL ALTERNATE ALLOWED.		RNATE ALLOWED.	DURO-LAST: LEE COBB, 800-434-3876 (PHONE)
						EXTERIOR FINISH SCHEDULE

2 DRIVE THRU WINDOW, SEE SHEET A1.0 AND A1.1.

(3) ROOF BEYOND.

4 STOREFRONT TYPICAL.

(5) DOUBLE DOOR.

6 SWITCH GEAR. PAINT TO MATCH WALL.

7 ARCHITECTURAL ALUMINUM AWNING BY VENDOR.

8 LIGHT SCONCE. ALIGN BOTTOM OF FIXTURES MOUNTING BRACKET WITH CHANGE IN EIFS THICKNESS (CENTER OF BRACKET AT 9'-2').

9 D/T LANE SURFACE IS 6" BELOW THE FINISH FLOOR.

REFER TO GRADING & SITE PLAN.

(10) 2° EIFS TO TERMINATE AT TOP OF WINDOW HEIGHT. PROVIDE 1° EIFS ABOVE THAT POINT. SLOPE TRANSITION AWAY FROM BUILDING 1:12.

11) EIFS (TYP). SEE 2 & 4/A62.

12 GALVANIZED METAL COPING. PAINT IN FIELD.

(13) CO2 FILLER VALVE & COVER. SEE DETAIL 5/A6.2 SIM.

(14) EIFS REVEAL JOINT.

TACO BELL

(16) WALL SHALL BE FINISHED PRIOR TO INSTALLATION OF SWITCHGEAR.

DREAK METAL COVER OVER WOOD STUDS TO MATCH STOREFRONT. SEE 3,4 & 7/A6.1

25 EXTEND FRAMING FOR BUMP-OUT DOWN TO ROOF. USE DETAIL 7/A6.2 FOR EIFS

KEY NOTES

21 HIGH IMPACT E.I.F.S. WHERE SHOWN ON ELEVATIONS. TOP EXTENT AT 5'-0'. SEE 2/A6.2.

SCUPPER, COLLECTOR, AND VERTICAL DOWNSPOUT 6' MIN. PAINT TO MATCH ADJACENT WALL.

(19) RTU BEYOND. PAINT TO MATCH MAIN BUILDING COLOR.

(23) BOLLARD. SEE CIVIL FOR ALL LOCATIONS.

(26) HOSE BIBB. SEE DETAIL 8/A6.2.

24 EIFS TRANSITION. SEE DETAIL 7/A6.2 (SIM.)

(18) SPLASH BLOCK.

(22) SPLASH BLOCK

3150 DIAL DRIVE COUNCIL BLUFFS, IA

14023.030

XXXXXX

XXX-XXX

XXXXX


MARCH 2015



LIVE MAS

EXTERIOR ELEVATIONS

PLOT DATE:

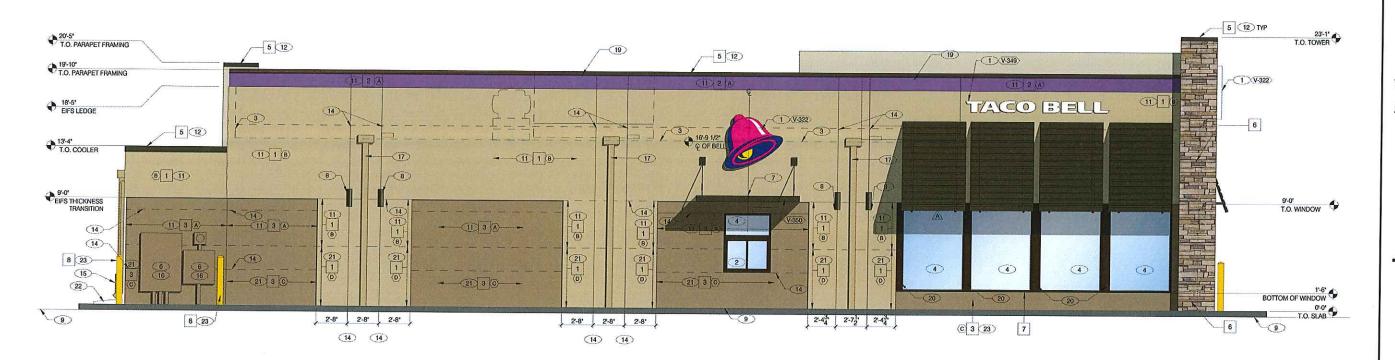


FRONT ELEVATION 1/4" = 1'-0" C



SEE SHEET A4.0 FOR KEYNOTES.

LEFT SIDE ELEVATION 1/4' = 1'-0' A



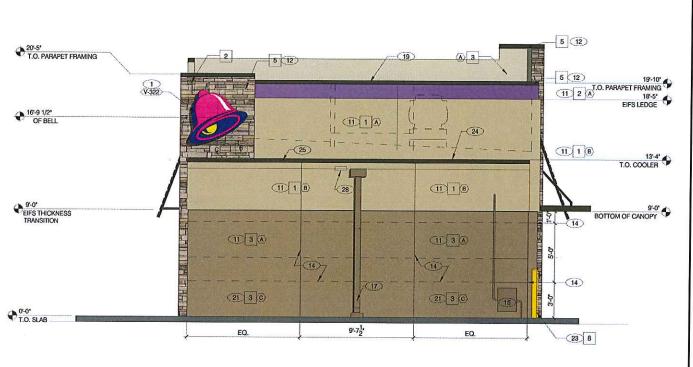

I hereby certify that this architectural document was prepared by me or under my direct personal supervision and that I am a duly licensed Professional Architect under the laws of the Nature of Jones.

Lee B. Manske

My license renewal date is June 30, 2

14023.030

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xx.xx

CONTRACT DATE: XXXXXX
BUILDING TYPE: LIVE MAS LARGE66
PLAN VERSION: MARCH 2015
SITE NUMBER: XXXXXXX
STORE NUMBER: XXXXXX

TACO BELL

3150 DIAL DRIVE COUNCIL BLUFFS, IA



LIVE MAS


EXTERIOR ELEVATIONS

A4.1

PLOT DATE:

REAR ELEVATION 1/4" = 1'-0" B

4-09-1

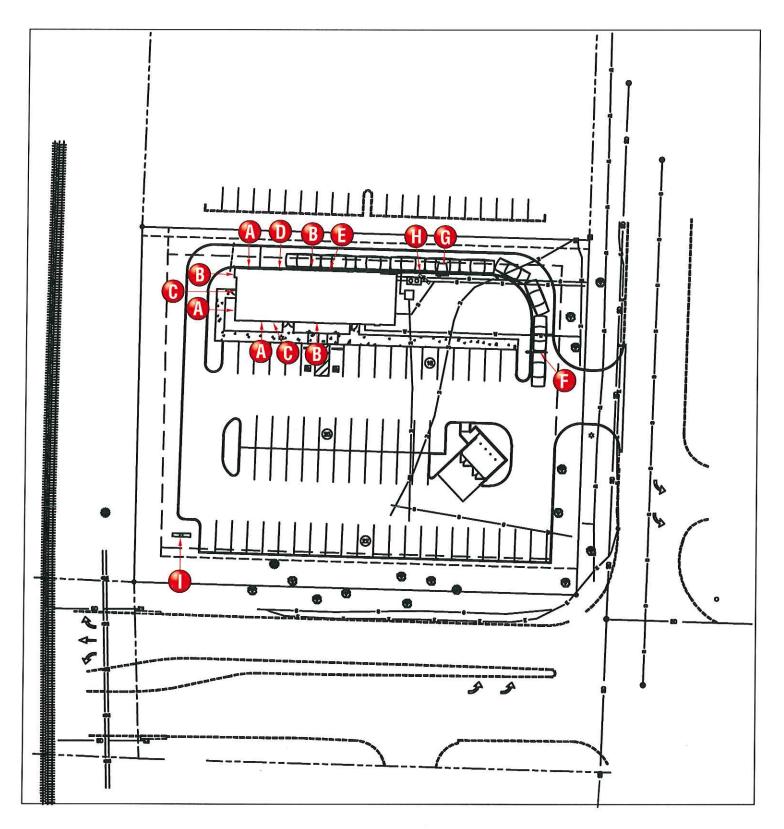

SITE PLAN - NTS

SIGN SCHEDULE

- 13 CUSTOM SLAT WALL AWNINGS
- 4 54" SWING BELLS
- 2 CUSTOM 18" TACO BELL LETTERS
- 1 12" TACO BELL LETTERS
- 1 9' DRIVE THRU CANOPY
- 1 -DRIVE THRU PORTAL
- 1- ORDER POINT CANOPY
- 1 DRIVE THRU MENU BOARD 1 - P-93 PYLON SIGN @ 24' OAH

25 TOTAL BUILDING ELEMENTS



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LARRY YEATS Project Manager:

J. CARPENTER Drawn By:

Project / Location:



3150 DIAL STREET **COUNCIL BLUFFS, IA 51501**

Underwriters
Laboratories Inc.

Laboratories Inc. ALL ELECTRICAL SIGNS ARE TO COMPLY WITH U.L. 48 AND ARTICLE 600 OF THE N.E.C. STANDARDS. INCLUDING THE PROPER GROUNDING AND BONDING OF ALL SIGNS.

WARRANTYNOTICE

Certain electrical components of signs will fail prematurely if not shut-off for a period of time, once, each day. For test performance, we recommend that signs be connected to an automatic Energy Management system. Time Clock or Photo Cell to control the day shut-off period. Failure to foldow these recommendations can cause damage to the signs' electrical components and viold the warranty. Some dimming devices will aches yell affect the electrical components of the sign to which it is attached, causing failure. Any dimming devices will ache you without prior consultation with Foderal Heath Sign Co., will void the warranty.

Client Approval/Date:

Landlord Approval/Date:

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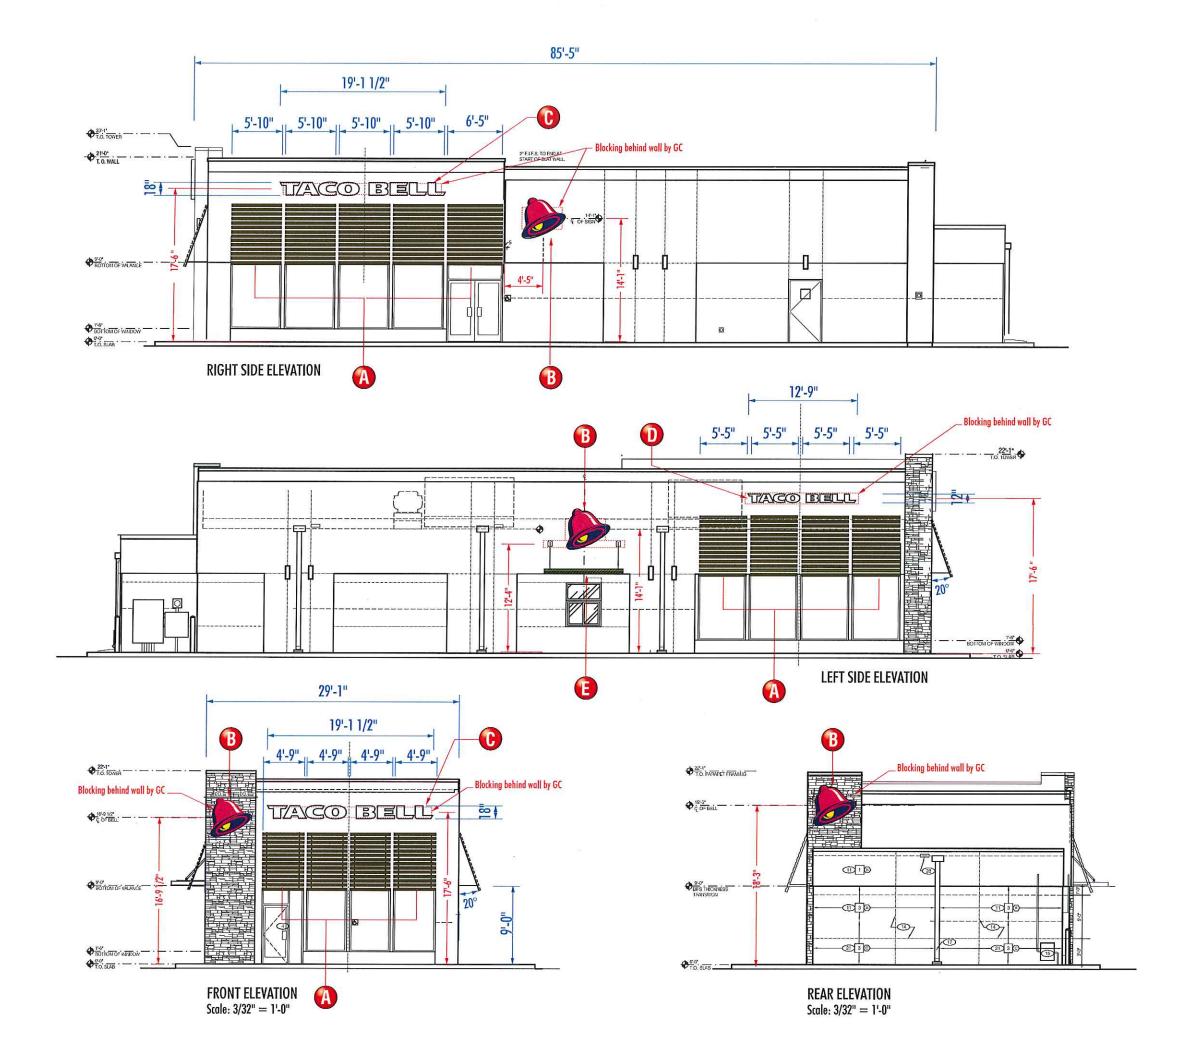
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LARRY YEATS Project Manager:

Drawn By:

J. CARPENTER

Project / Location:



3150 DIAL STREET **COUNCIL BLUFFS, IA 51501**

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Underwriters Laboratories Inc.	nec	COMPONENTS AND ALL N.E.C. ST

ALL ELECTRICAL SIGNS ARE TO COMPLY WITH U.L. 48 AND ARTICLE 600 OF THE N.E.C. STANDARDS, INCLUDING THE PROPER GROUNDING AND BONDING OF ALL SIGNS. WARRANTYNOTICE

Certain electrical components of signs will fall prematurely if not shut-off for a period of time, once, each day. For best performance, we recommend that signs be connected to an automatic Energy Management system. Time Clock or Photo Cell to control the daily shut-off period. Failure to follow these recommendations can use damage to the signs' electrical components and void the warranty. Some dimning devices will achievely affect the electrical components of the sign to which it is attached, causing failure. Any dimning devices of the sign without prior consultation with Federal Heath Sign Co, will void the warranty.

Client Approval/Date:

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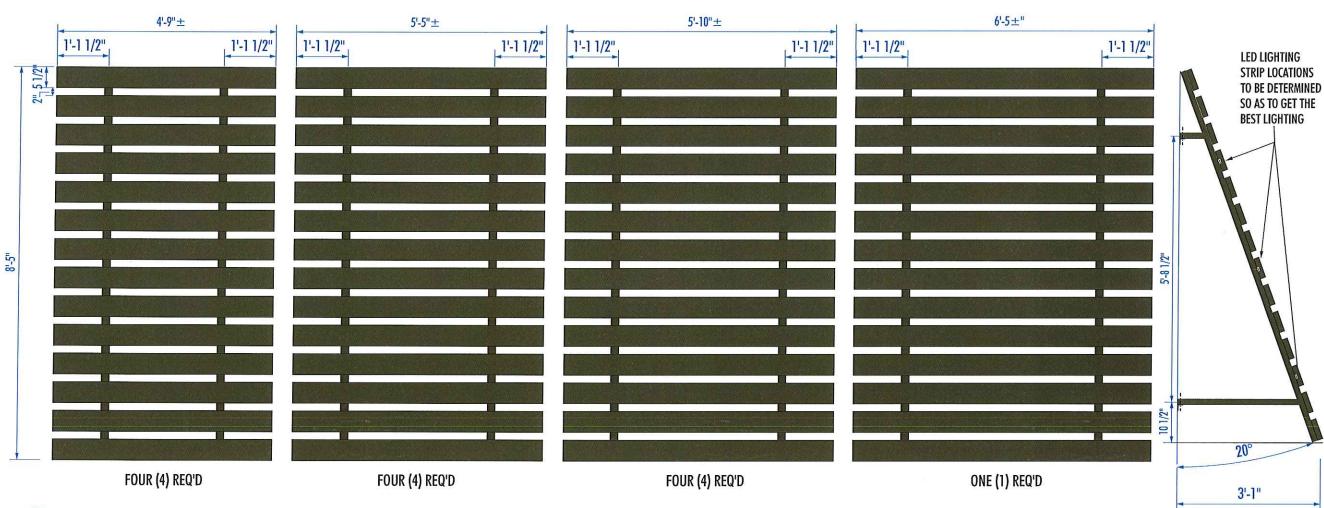
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2 Of **11**



FIELD SURVEY REQUIRED


PRIOR TO PRODUCTION



CUSTOM SLAT WALL AWNINGS

SCALE: 1/2"=1'-0"

ALUMINUM SLAT WALL AWNINGS TO HAVE STATUS BRONZE FINISH ON SLATS AND SUPPORT STRUCTURE.

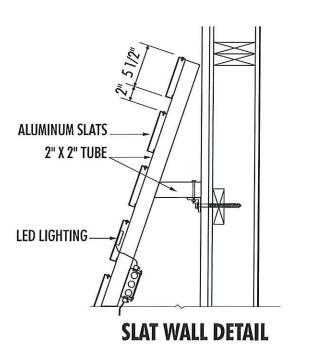



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J. CARPENTER Drawn By:

Project / Location:



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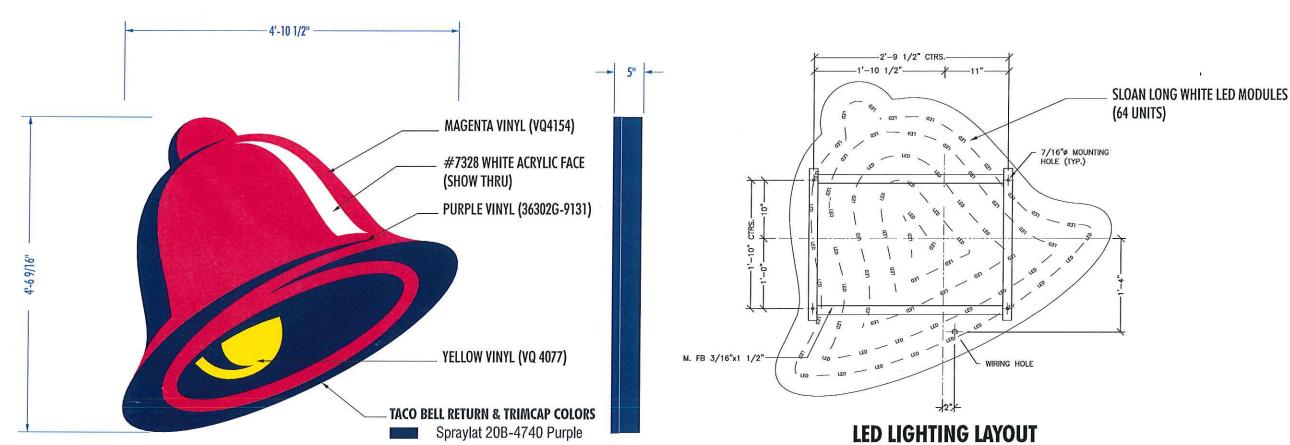
3 Of 11

V-322

4 REQUIRED TACO BELL 4'-6" SWINGING BELL (LED LIGHTED) Formed Face



AREA = 22.166 SQ./FT.



FORMED FACE CHANNEL SWINGING BELL SCALE: $\frac{3}{4}$ " = 1'-0"

DEDICATED CIRCUITS

One 120v - 20 Amp Circuit Reg'd (1 AMP)

ALL BRANCH CIRCUITS SHALL BE DEDICATED TO SIGNS(INCLUDING GROUND AND NEUTRAL) AND

SHALL NOT BE SHARED WITH OTHER LOADS

PART NO: TB1045CS.0SBLD

UFPC NO:

EST NO: 58140117

Purple Aluminum Letter Returns with White Interior Finish 14 AWL Wire Whip Out Back of Letter-Installer to Hook-up to Power Supply (All Wall Penetrations to be Sealed w/ Silicone) L.E.D Modules _ 22 Ga Metal Transformer Box **Building Wall. Booted Toggle Switch on Box** 120v/12vdc Power Supply Formed Capover 3/16" Acrylic Faces (Mount In Dry Area Only) 1/2" Ø Metal Pass-Thru In Wall For Supply Leads .063 Aluminum Letter Backs (By Installer) **Electrical To Power Supply In** Flexible Conduit (by Installer) J-Box And Final Primary Hook-up Non-Corrroisve Type Mounting Hardware By G.C. Electrician. Appropriate for Wall Material-By Installer Primary to Sign Location By G.C. Electrician (Three Min. Per Letter) (120v-20 amp circuit) 1/4" Drain

SECTION DETAIL - LED ILLUMINATED BELL



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LARRY YEATS Project Manager

J. CARPENTER

Project / Location:



3150 DIAL STREET **COUNCIL BLUFFS. IA 51501**

(UL)	Underwriters Laboratories Inc.	(nec)	CO
ALL E	ECTRICAL SIGNS	ARE TO	co

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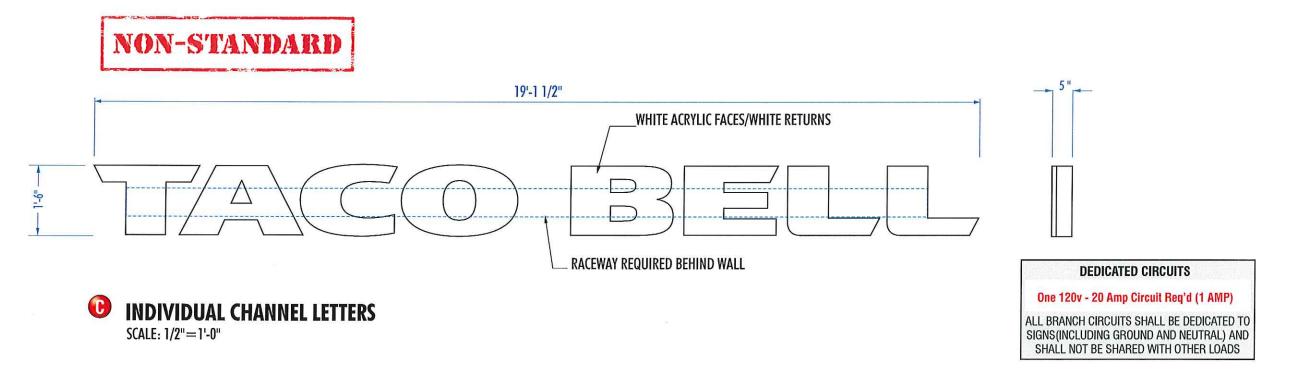
4 of 11

V-349c

2 REQUIRED TACO BELL 18" WHITE CHANNEL LETTERS (LED LIGHTED)




AREA = 28.68 SQ./FT.



LOW VOLTAGE L.E.D. LIGHTING SYSTEM

U.L. LISTED CLASS 2 - CONFORMS TO U.L. 48 & NEC 600 CODE

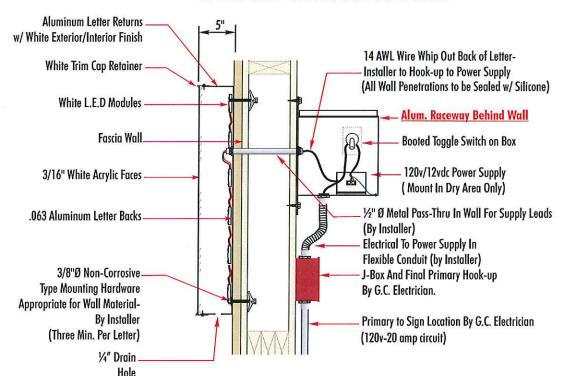

SECTION DETAIL - LED ILLUMINATED WALL LETTERS



SIGN COMPANY

2300 North Highway 121 Euless, Texas 76039 (817) 685-9077 (800) 527-9495 Fax (817) 685-9103

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MICHELLE BUSING Account Rep:

LARRY YEATS

Drawn By: J. CARPENTER



3150 DIAL STREET **COUNCIL BLUFFS, IA 51501**

Underwriters Laboratories Inc.	ELECTRICAL TO USE U.L. LISTED COMPONENTS AND SHALL MEET ALL N.E.C. STANDARDS
LL ELECTRICAL SIGNS ARE TO	
RTICLE 600 OF THE N.E.C.	. STANDARDS, INCLUDING
HE PROPER GROUNDING AN	D BONDING OF ALL SIGNS.

WARRANTYNOTICE

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Client Approval/Date:

Landlord Approval/Date:

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Job Number:

23-30599-10

MARCH 31, 2015


Sheet Number: 5 Of 11


V - 349

1 REQUIRED TACO BELL 12" WHITE CHANNEL LETTERS (LED LIGHTED)



AREA = 12.75 SQ./FT.

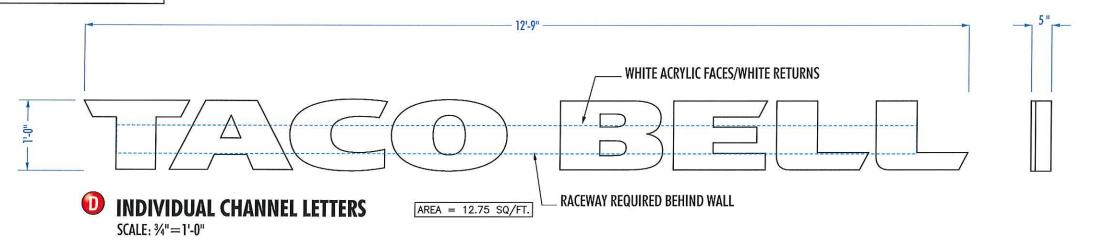

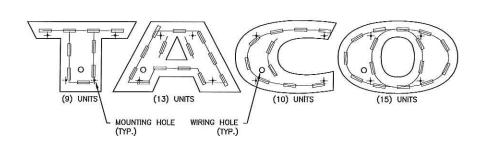

- SLOAN VL-PLUS SHORT WHITE LED MODULES (96 =39') REMOTE POWER SUPPLY [MOD 60 @ 1 AMP] __ (13) UNITS (9) UNITS

DEDICATED CIRCUITS

One 120v - 20 Amp Circuit Reg'd (1 AMP)

ALL BRANCH CIRCUITS SHALL BE DEDICATED TO SIGNS(INCLUDING GROUND AND NEUTRAL) AND SHALL NOT BE SHARED WITH OTHER LOADS

LED LIGHTING LAYOUT

SCALE: 3/4"=1'-0"

PART NO: TB4012LD.OID

LOW VOLTAGE L.E.D. LIGHTING SYSTEM U.L. LISTED CLASS 2 - CONFORMS TO U.L. 48 & NEC 600 CODE

14 AWL Wire Whip Out Back of Letter-White Trim Cap Retainer Installer to Hook-up to Power Supply (All Wall Penetrations to be Sealed w/ Silicone) White L.E.D Modules _ Alum. Raceway Behind Wall Fascia Wall **Booted Toggle Switch on Box** 120v/12vdc Power Supply 3/16" White Acrylic Faces (Mount In Dry Area Only) 1/2" Ø Metal Pass-Thru In Wall For Supply Leads .063 Aluminum Letter Backs (By Installer) **Electrical To Power Supply In** Flexible Conduit (by Installer) 3/8"Ø Non-Corrosive J-Box And Final Primary Hook-up Type Mounting Hardware By G.C. Electrician. Appropriate for Wall Material-By Installer Primary to Sign Location By G.C. Electrician (Three Min. Per Letter) (120v-20 amp circuit) 1/4" Drain

SECTION DETAIL - LED ILLUMINATED WALL LETTERS

Hole

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MICHELLE BUSING

LARRY YEATS

J. CARPENTER Drawn By:

Project / Location:



3150 DIAL STREET **COUNCIL BLUFFS, IA 51501**

Underwriters Laboratories Inc.	nec	COMPONENTS A	
ALL ELECTRICAL SIGNS	ARE TO	COMPLY WITH	
ARTICLE 600 OF THE	N.E.C.	STANDARDS.	

WARRANTYNOTICE

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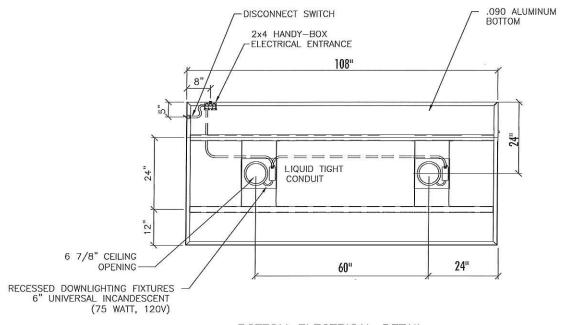
Sheet Number:

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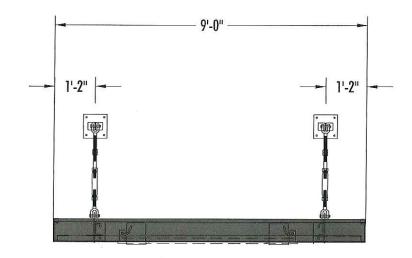
1 REQUIRED TB DRIVE THRU CANOPY- 9'-0" X 4'-0" X 6"



hardware is provided by installer due to unknown wall conditions



BOTTOM ELECTRICAL DETAIL







SIGN SPECIFICATIONS:

SIGN SIZE:

AREA ... CLOSED RECTANGLE 36.0 SQ.FT.

ACTUAL SIZE ... 6" x 48" x 108" APPROXIMATE WEIGHI ... 160 LBS DESIGNED WINDLOAD ... 110 MPH (3-SEC. GUST EXPOSURE C) DESIGNED FOR GROUND SNOW LOAD ... 20PSF COMPLIENT w/ NATIONAL BUILDING CODES & STANDARDS (IBC, UBC, BOCA, AISC, ASCE7, ACI, & ALUM. DSGN. MANUAL)

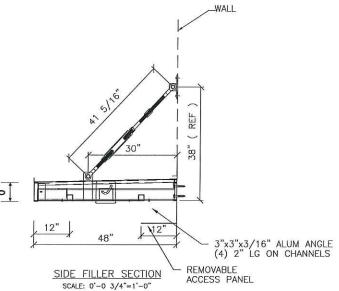

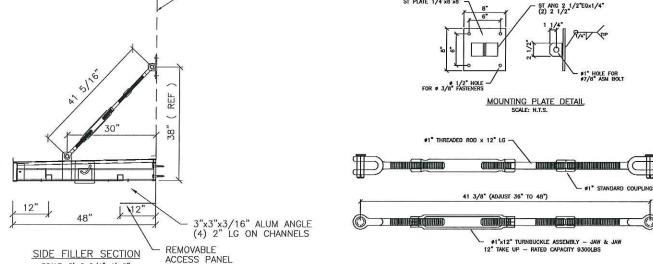

TURNBUCKLE COMPONENT ASSEMBLY



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MICHELLE BUSING

LARRY YEATS Project Manager

J. CARPENTER

Project / Location:



3150 DIAL STREET **COUNCIL BLUFFS, IA 51501**

Underwriters Laboratories Inc. (F) ELECTRICAL TO USE U.L. LISTED COMPONENTS AND SHALL MEET ALL N.E.C. STANDARDS

WARRANTYNOTICE

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23-30599-10

Date:

MARCH 31, 2015

Sheet Number:

7 Of 11

Design Number: 23-30599-10

EST. NO: 50-01156-71

COLORS:

PAINT TO MATCH: TB BRONZE TO MATCH TIGER DRYLAC 49-66230 C-33 (LACRYL B20-4694)

V-319

TB9EVPOR.10

1 REQUIRED 10'-0" EVOLUTION PORTAL






- 11'-10 13/16" 9'-4 9/16" **-1**'-2 9/16"-9'-0" Don't Ring Your ┣ On This! ADJUSTABLE MOUNTING PLATE & HINGE ASSEMBLY **TOP VIEW** - ALUMINUM BASE/

SEE ENGINEERING DETAIL DRAWING FOR FOUNDATION REQUIREMENTS

FRONT ELEVATION

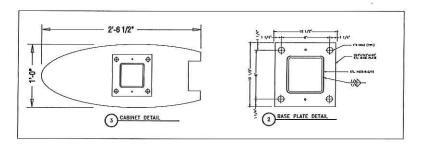

DESIGN PARAMETERS:

- · Structural adequacy shall be the manufacturer's responsibility using the following criteria:
- · 110 mph wind speed 3-second gust-Exposure C.
- 300 PSF per foot of depth allowable lateral soil bearing pressure.
- · Compliant with latest edition national building codes and standards (IBC, AISC, ASCE 7, ACI & Aluminum Design Manual)
- · Refer to written documentation for material specifications

TB EVOLUTION DT PORTAL

.125 Polycarbonate base with screened decoration second surface 1/8" Aluminum formed bell mounted to face 6"x6"x3/16" Steel tube column Adjustable mounting plate and hinge assembly for clearnace bar 4" PVC tube sleeved over 2"x3" steel tube for clearance bar Removable shroud for install - bottom "kick plate"

Aluminum cladding close off - end panel **GRAPHIC & COLOR SPECIFICATIONS:**

TB Bronze Tiger Drylac 49-66230 C33

Plum PMS 2685U

Amber Wave SW-6657 PMS 138U

PMS 131U

6 PMS 139U

6 Yellow PMS 108U

Pantone Process Magenta U

Pantone Violet U

Pantone Black

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Account Rep:	MICHELLE BUSING
Project Manager:	LARRY YEATS
Drawn By:	J. CARPENTER



3150 DIAL STREET COUNCIL BLUFFS, IA 51501

Underwriters Laboratories Inc.	nec	ELECT COME ALL	RICAL TO ONENTS N.E.C.	USE U.L. AND SHAI STANE
ELECTRICAL SIGNS				
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WARRANTYNOTICE W.A.K.K.A.N.I.Y.N.O.J.C.E.
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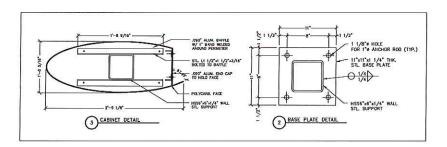
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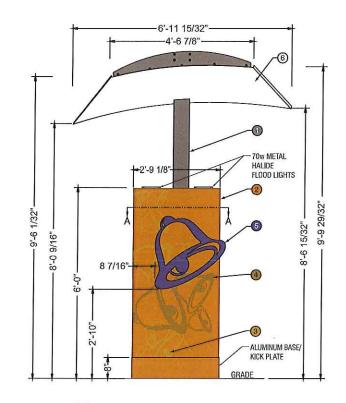
V-320

TB9EVOPC.12 1 REQUIRED

EVOLUTION ORDER POINT CANOPY








SEE ENGINEERING DETAIL DRAWING FOR FOUNDATION REQUIREMENTS



120V-20 AMP CIRCUIT ELECTRICAL PRIMARY TO SIGN LOCATION AND THE FINAL HOOK-UP TO BE BY CUSTOMER'S CERTIFIED ELECTRICIAN. NUMBER OF CIRCUITS REQUIRED PER IGN TO BE PER FEDERAL HEATH SIGN ENGINEERING SPECIFICATIONS AND REQUIREMENTS. ALL SIGNS TO COMPLY WITH U.L. 48 REQUIRMENTS AND ARTICLE 600 OF THE N.E.C., AND ALSO MEET ANY STATE AND LOCAL CODE REQUIREMENTS. ALL BRANCH CIRCUITS, INCLUDING GROUND AND NEUTRAL, TO BE DEDICATED TO SIGNS ONLY AND NOT SHARED WITH OTHER LOADS.

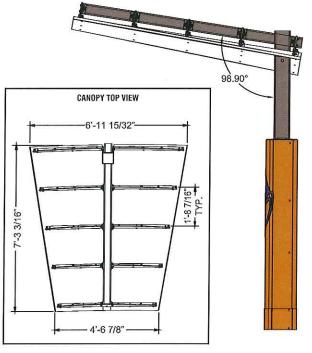

DESIGN PARAMETERS:

- · Structural adequacy shall be the manufacturer's responsibility using the following criteria:
- · 110 mph wind speed 3-second gust-Exposure C.
- · 300 PSF per foot of depth allowable lateral soil bearing pressure.
- Compliant with latest edition national building codes and standards (IBC, AISC, ASCE 7, ACI & Aluminum Design Manual)
- · Refer to written documentation for material specifications

TB EVOLUTION DT CANOPY

.125 Polycarbonate base with screened decoration second surface 1/8" Aluminum formed bell mounted to face 6"x6"x1/4" Steel tube column 4"x4"x1/4" Steel tube horizontal canopy support .063 Aluminum canopy deck 1/4" Steel rib plates - rafters Removable shroud for install - bottom "kick plate" Aluminum cladding close off - end panel

Electrical:

Lamps:

(2) Flood lights - 70w Metal Halide

Circuits: (1) 20 amp circuits 60 HZ - UL 48 & NEC compliant

GRAPHIC & COLOR SPECIFICATIONS:

COLOR

TB Bronze Tiger Drylac 49-66230 C33

Amber Wave SW-6657 PMS 138U

③ PMS 131U

PMS 139U

6 Plum PMS 2685U 6 White Matte

FEDERAL

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Revisions:		
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MICHELLE BUSING

LARRY YEATS Project Manager:

Drawn By:

J. CARPENTER

Project / Location:



3150 DIAL STREET **COUNCIL BLUFFS, IA 51501**

Underwriters Laboratories Inc. The Components and shall meet ALL N.E.C. STANDARDS ALL ELECTRICAL SIGNS ARE TO COMPLY WITH U.L. 48 AND ARTICLE 600 OF THE N.E.C. STANDARDS, INCLUDING THE PROPER GROUNDING AND BONDING OF ALL SIGNS.

WARRANTYNOTICE

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Job Number:

23-30599-10

Date:

MARCH 31, 2015

Sheet Number:

9 Of 11

V-302L 1 REQUIRED

BRB EVOLUTION DRIVE THRU MENU BOARD w/ NO ARCH





(1) FRONT ELEVATION

20V-20 AMP CIRCUIT ELECTRICAL PRIMARY TO SIGN LOCATION AND THE FINAL HOOK-UP TO BE BY CUSTOMER'S CERTIFIED ELECTRICIAN. NUMBER OF CIRCUITS REQUIRED PER SIGN TO BE PER FEDERAL HEATH SIGN ENGINEERING SPECIFICATIONS AND REQUIREMENTS. ALL SIGNS TO COMPLY WITH U.L. 48 REQUIRMENTS AND ARTICLE 600 OF THE

N.E.C., AND ALSO MEET ANY STATE AND LOCAL CODE REQUIREMENTS. ALL BRANCH CIRCUITS, INCLUDING GROUND AND NEUTRAL, TO BE DEDICATED TO SIGNS ONLY AND NOT SHARED WITH OTHER LOADS.

SIGN SPECIFICATIONS

Materials
• Cabinet: Extruded aluminum
• Face: .150 S/G Polycarbanate

Access
• Open doors & remove panels

Area
• Squared: 66.5 Sq.Ft.
Weight (Est.)
• 950 lbs. Crated

Wind Load • 50 PSF, 110 MPH wind speed 3 second gust -

• (4) F025/741 36" 4100K, (10) F032/741 48" 4100K (2) F040/741 60" 4100K

Ballast

• (7) Electronic ballasts @ .58 amps each

• (1) Electronic ballasts @ .17 amps

• (2) Electronic ballasts @ 1.15 amps

Line Load

• 4.09 Amps @ 120 VAC

• (1) 15 Amp clouit, 60 Hz UL 48 & NEC Compilant

COLOR SPECIFICATIONS

Interfor: Mill Finish Exterior: Cabinot: Tiger Drylac 49/66230-33 Bronzo Doors & Mullions: Black Graphic & Color Specifications: Tiger Drylac 49/66230-33 Bronzo

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MICHELLE BUSING Account Rep:

LARRY YEATS Project Manager

J. CARPENTER Drawn By:

Project / Location:



TACO BELL

3150 DIAL STREET COUNCIL BLUFFS, IA 51501

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Sheet Number:

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1 REQUIRED TACO BELL PYLON SIGN P-93-BF





SCALE: 1/4'' = 1'-0''

DESIGN PARAMETERS:

- 110 mph wind speed 3-second gust-Exposure C.
- 300 PSF per foot of depth allowable lateral soil bearing pressure.
- · Compliant with national building codes and standards (IBC, UBC, BOCA, AISC, ASCE 7, ACI & Aluminum Design Manual)
- · Refer to written documentation for material specification details

TB-P93 - DFTACO BELL PYLON CABINET Sq. Ft: 93.0

- Extruded aluminum frame, 10" deep with 2" retainer.
- Aluminum painted fillers
- .187 Pan formed and embossed SG polycarbonate with retention strips
- Hingeable access
- · Approximate weight: 600 lbs.

Electrical: Lamps:

(8) F96T12DSGN50/HO

(2) U-Lamp U9-72T12DSGN50/HO

(2) U-Lamp U9-96T12DSGN50/HO


Ballast: (2) 6 Lamp electronic ballast (2.5 amps each)

Amp Load: 5.0 amps/120 volts Circuits:

(1) 20 amp circuits 60 HZ - UL 48 & NEC compliant

TACO BE	LL COLORS	VINYL	PAINT
	Yellow	VQ4077	L8-7836
ACCES.	Magenta	3632G-1450	L8-7837
MA	Purple	3632G-9131	L8-7917
	White	Face	L8-3124

Purple Paint MP80288

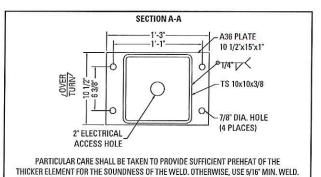

120Y-20 AMP CIRCUIT ELECTRICAL PRIMARY TO SIGN LOCATION AND THE FINAL HOOK-UP TO BE BY CUSTOMER'S CERTIFIED ELECTRICIAN. NUMBER OF CIRCUITS REQUIRED PER SIGN TO BE PER FEDERAL HEATH SIGN ENGINEERING SPECIFICATIONS AND REQUIREMENTS ALL SIGNS TO COMPLY WITH U.L. 48 REQUIRMENTS AND ARTICLE 600 OF THE N.E.C., AND ALSO MEET ANY STATE AND LOCAL CODE REQUIREMENTS ALL BRANCH CIRCUITS, INCLUDING GROUND AND NEUTRAL, TO BE DEDICATED TO SIGNS ONLY AND NOT SHARED WITH OTHER LOADS.

STANDARD INSTALL IS TO BE DIRECT PIPE EMBEDMENT INTO CONCRETE FOOTING PER FH ENGINEERING SPECS.



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www.FederalHeath.com

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Account Rep:	MICHELLE BUSING
Project Manager:	LARRY YEATS

J. CARPENTER Drawn By:



3150 DIAL STREET **COUNCIL BLUFFS, IA 51501**

Underwriters
Laboratories Inc.

(F)
COMPONENTS AND SHALL MEET
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